
SUBSET 06 - SITE SECURITY INDEX OF DRAWINGS

06.01 06.02 06.03 06.04	SITE SECURITY SUBSET COVER SHEET SITE SECURITY PLAN-1 SITE SECURITY PLAN-2 SITE SECURITY DETAILS	
06.03	SITE SECURITY PLAN-2	
06.04	SITE SECURITY DETAILS	

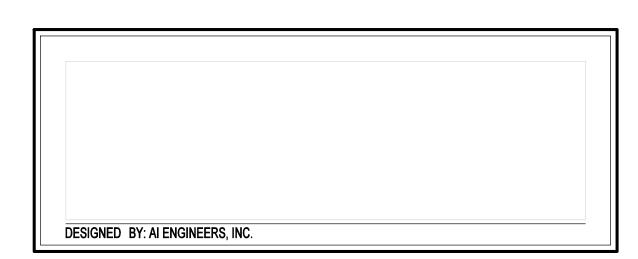

				THE INFORMATION, INCLUDING ESTIMATED
				QUANTITIES OF WORK, SHOWN ON THESE SHEETS IS BASED ON LIMITED
				INVESTIGATIONS BY THE STATE AND IS IN NO WAY WARRANTED TO INDICATE
				THE CONDITIONS OF ACTUAL QUANTITIES OF WORK WHICH WILL BE REQUIRED.
				OF WORK WHICH WILE BE REQUIRED.
7	DATE	REVISION DESCRIPTION	SHEET NO	Plotted Date: 11/7/2014


STATE OF CONNECTICUT **DEPARTMENT OF TRANSPORTATION** Filename: 16_SSIN_3010088_SS-000.dgn

NEW HAVEN RAIL YARD FACILITIES IMPROVEMENTS YARD POWER UPGRADE

NEW HAVEN

SITE SECURITY

301-0144 SS-000 SUBSET COVER SHEET

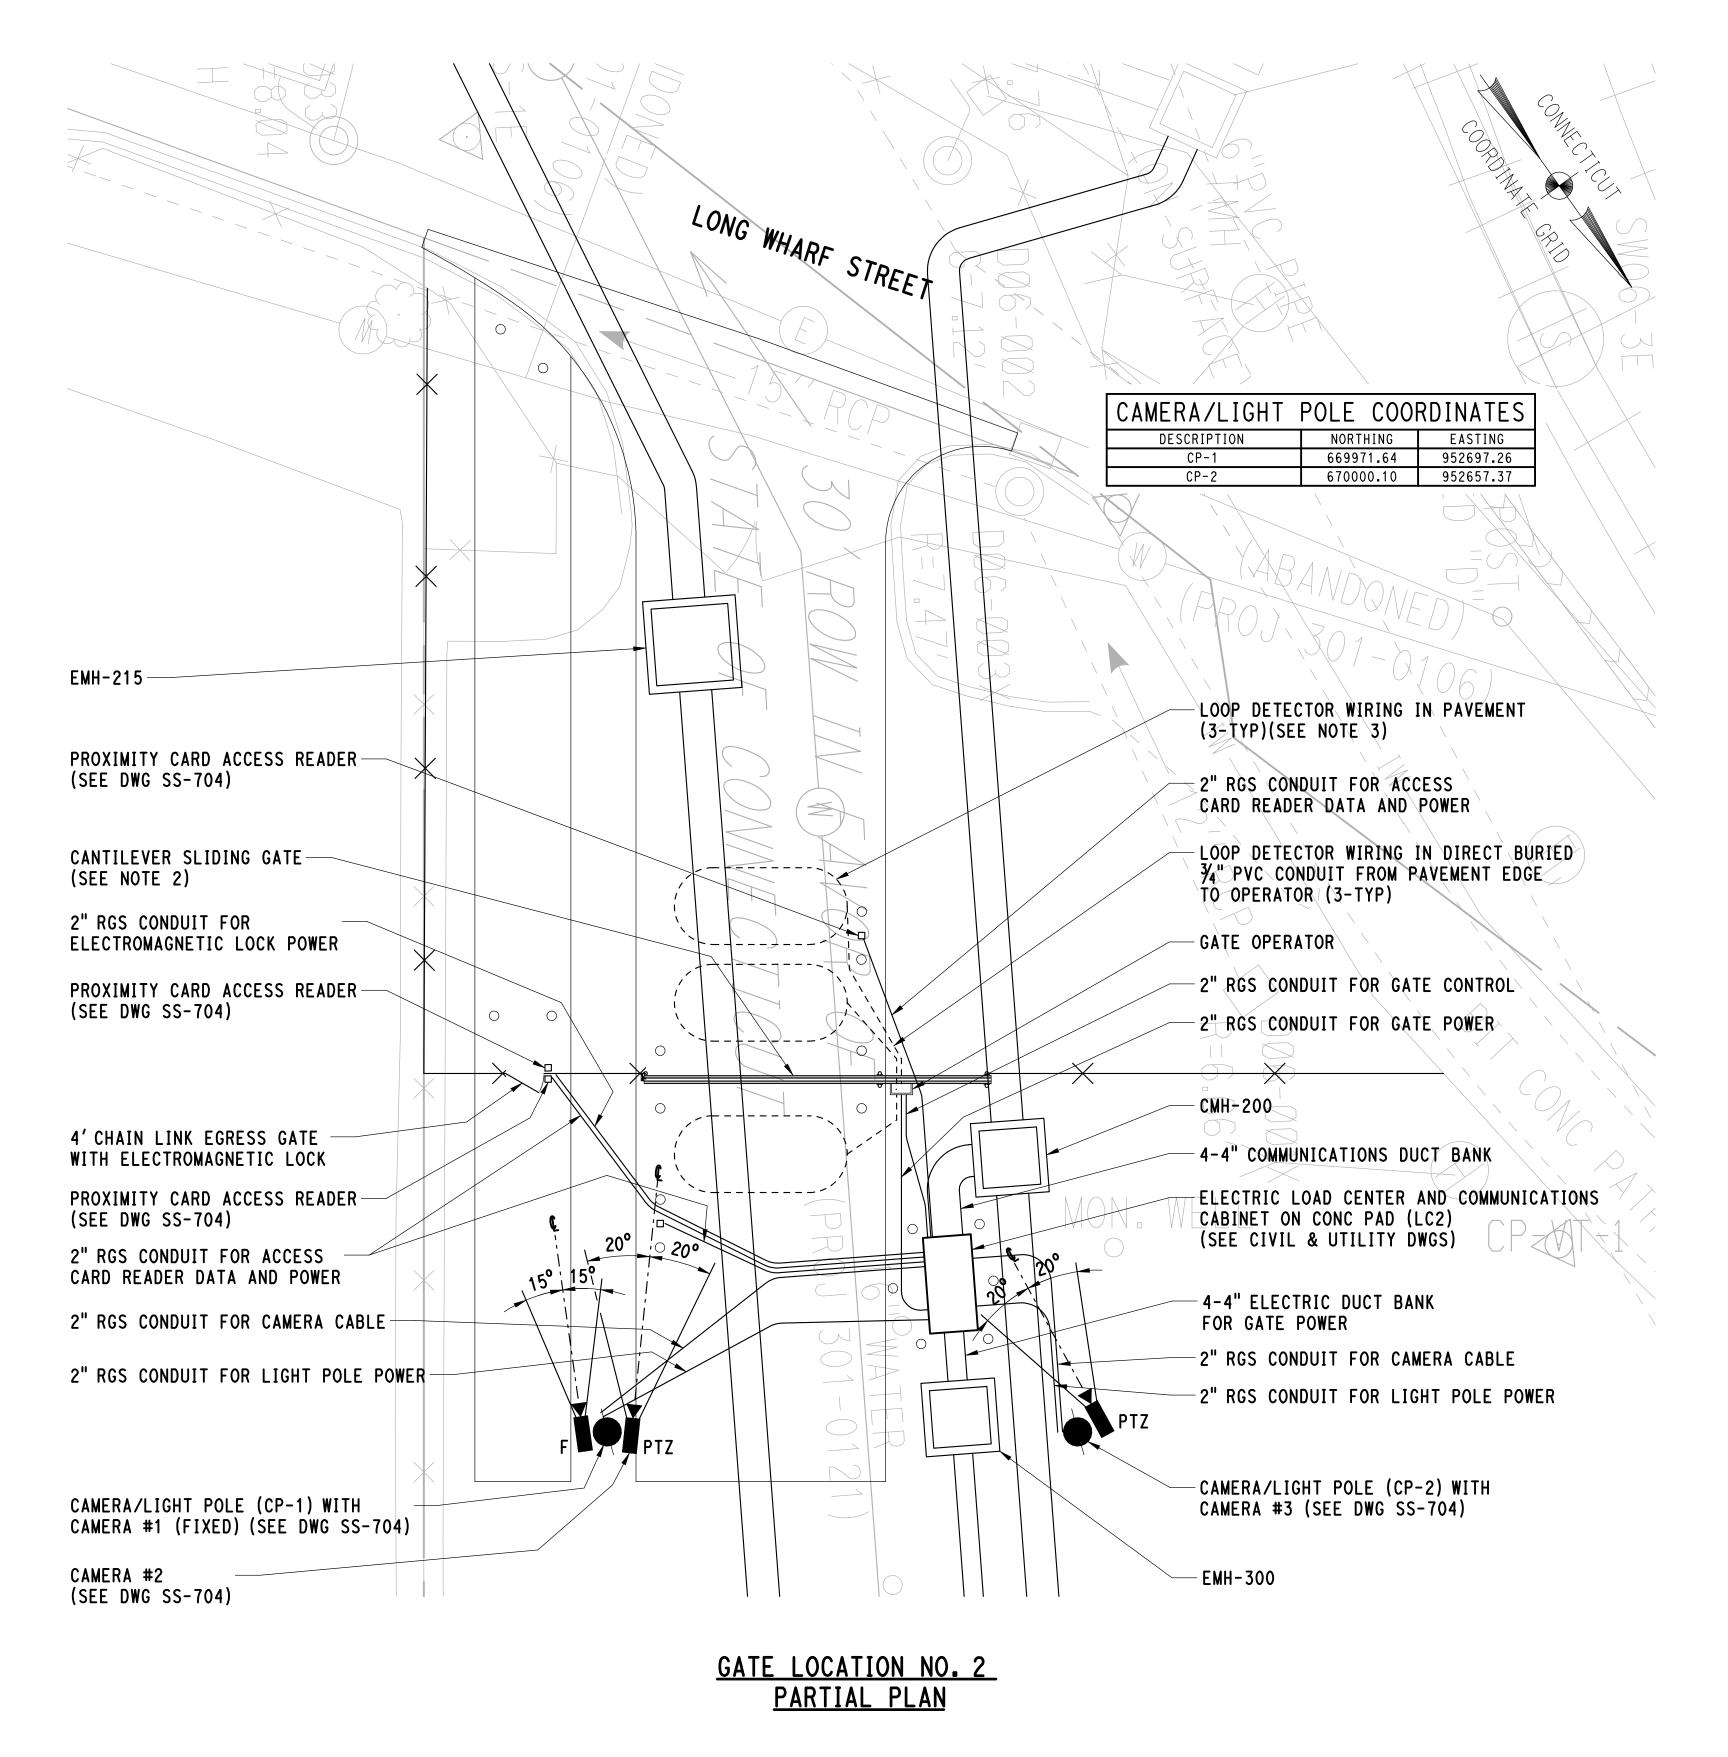

NOTES:

- 1. REFER TO CIVIL DRAWINGS FOR GATE LOCATIONS.
- 2. REFER TO CIVIL DRAWINGS AND SPECIFICATIONS FOR CANTILEVER SLIDING GATE AND HYDRAULIC OPERATOR DETAILS.
- 3. PROVIDE LOOP DETECTOR INSTALLATION PER MANUFACTURERS INSTRUCTIONS. DETERMINE FINAL DIMENSIONS AND LOCATIONS IN THE FIELD.
- 4. 2" RGS CONDUITS SHOWN SHALL BE PAID UNDER ITEM "2" RIGID METAL CONDUIT UNDER ROADWAY".

REVISION DESCRIPTION SHEET NO. Plotted Date: 11/7/2014 REV. DATE

SG/MA JWL SCALE IN FEET SCALE 1"=10'







NEW HAVEN RAIL YARD FACILITIES IMPROVEMENTS YARD POWER UPGRADE

NEW HAVEN DRAWING TITLE: SITE SECURITY

PLAN-1

301-0144 SS-701 SHEET NO. 06.02

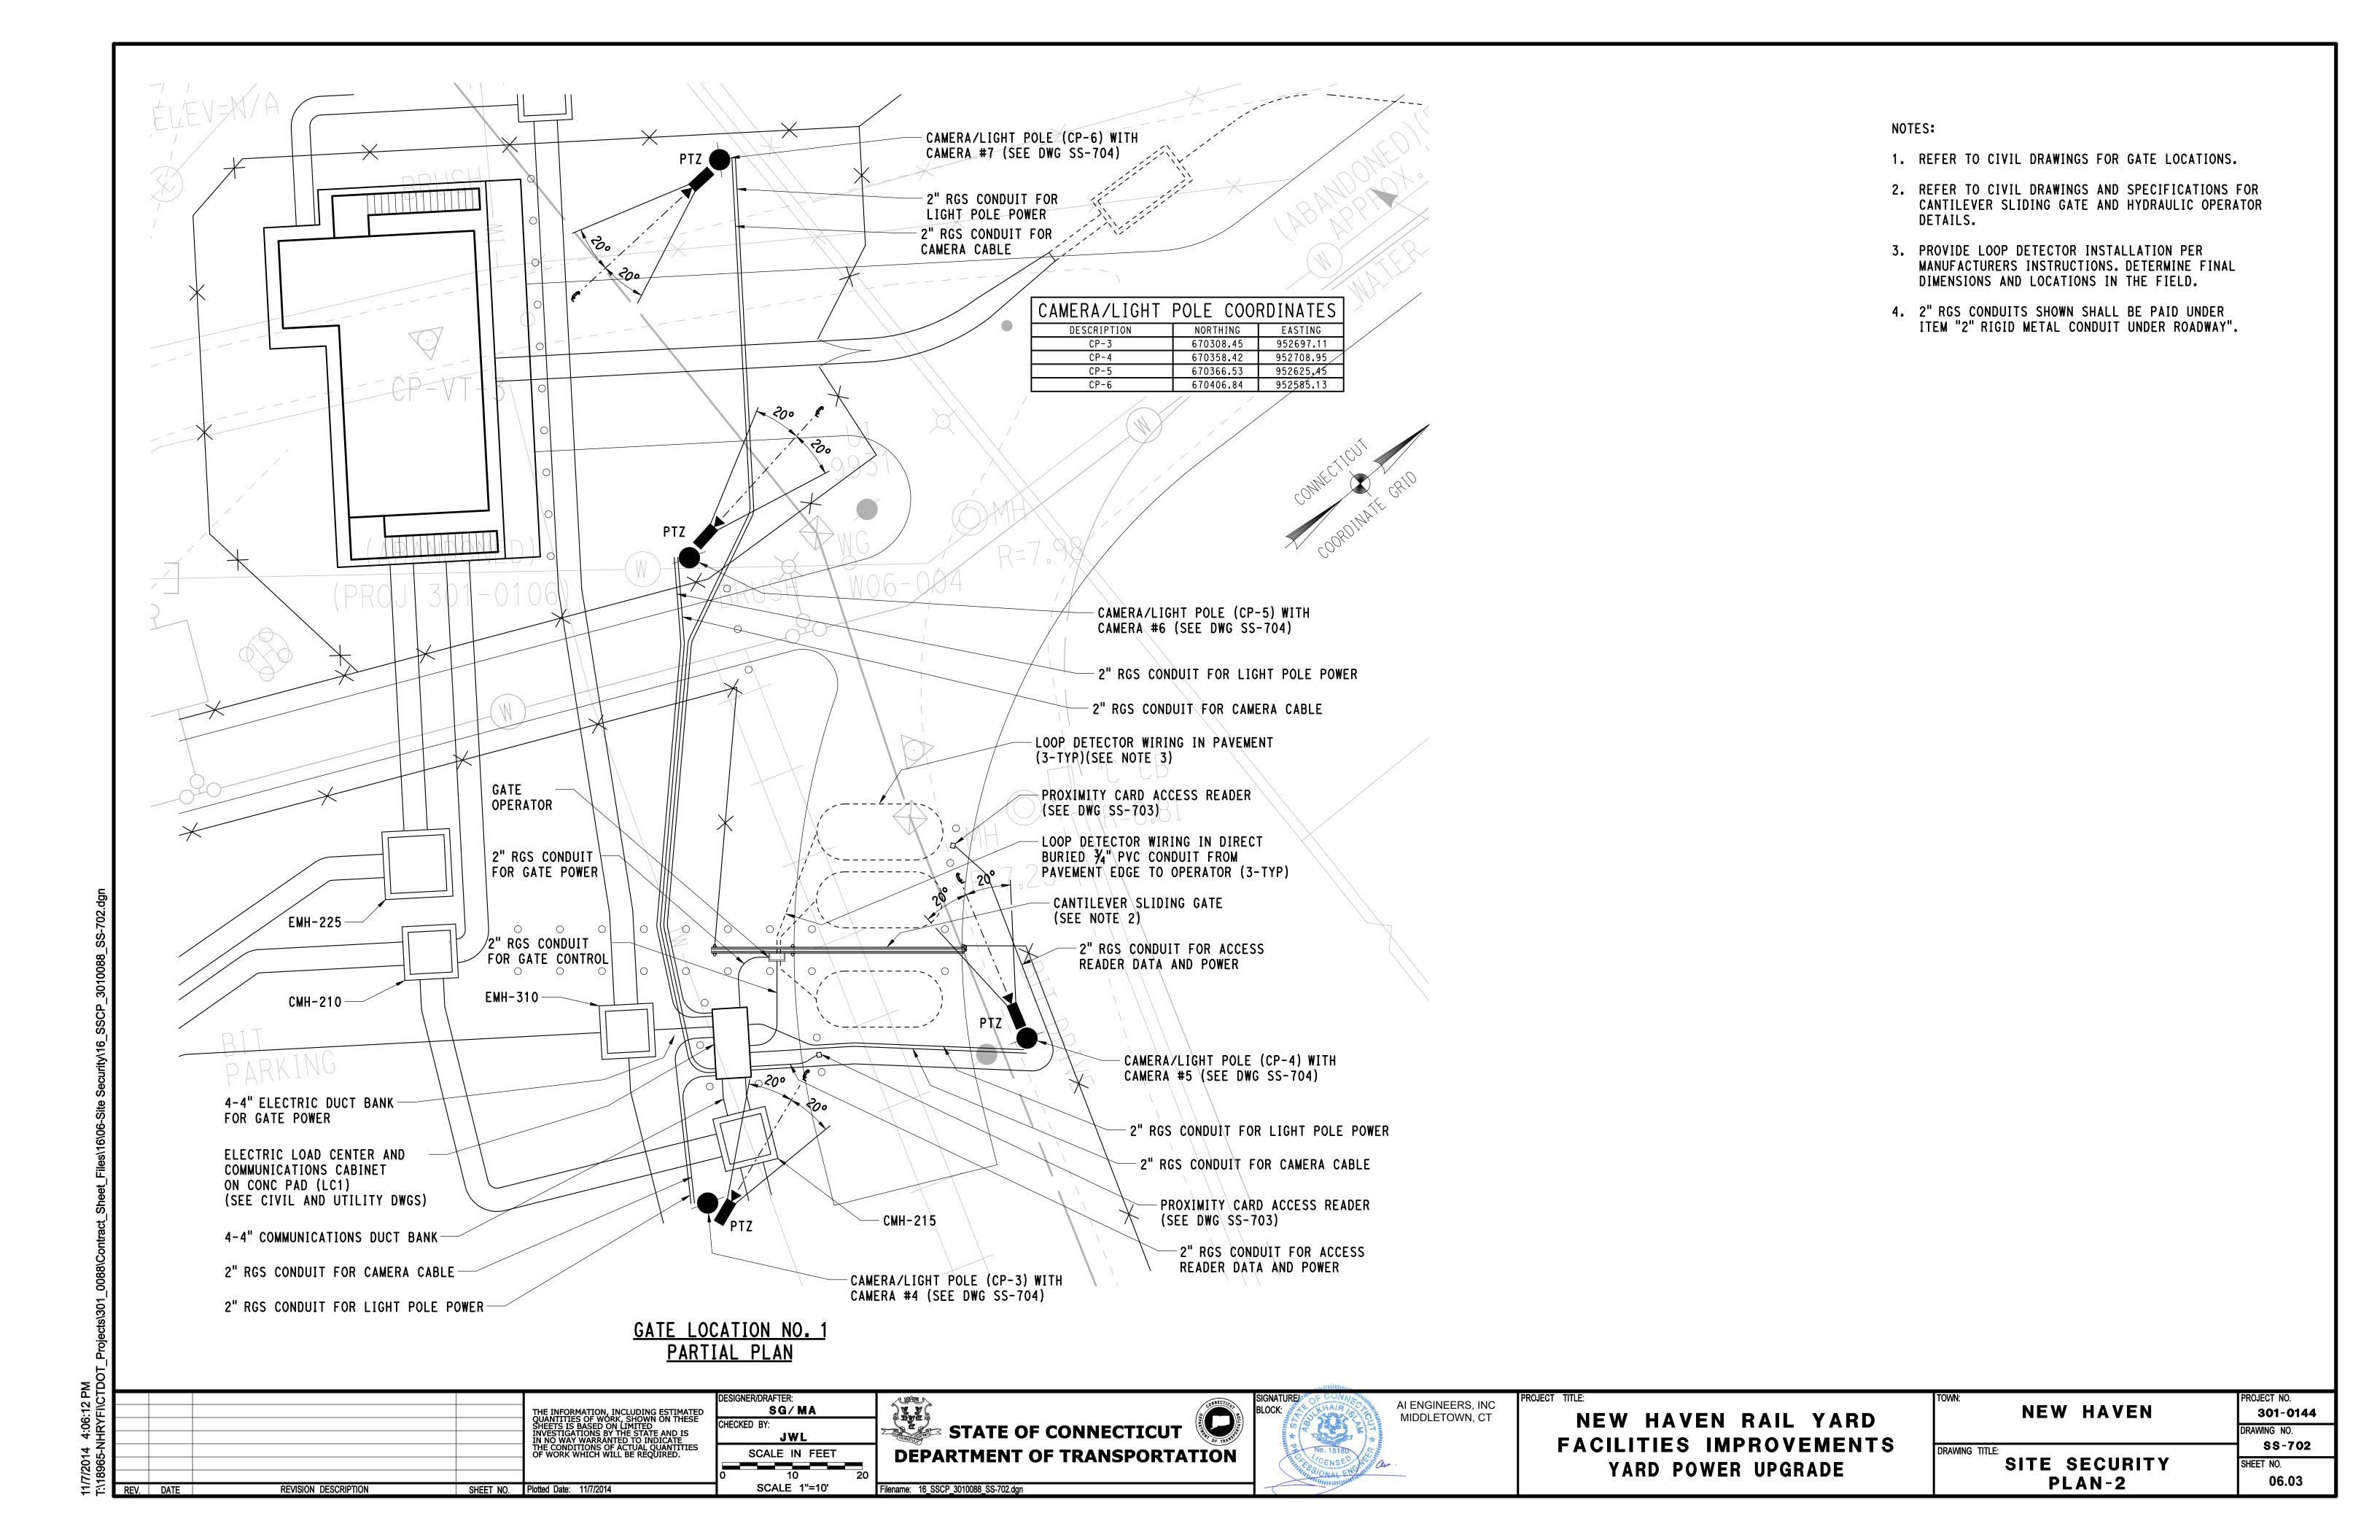


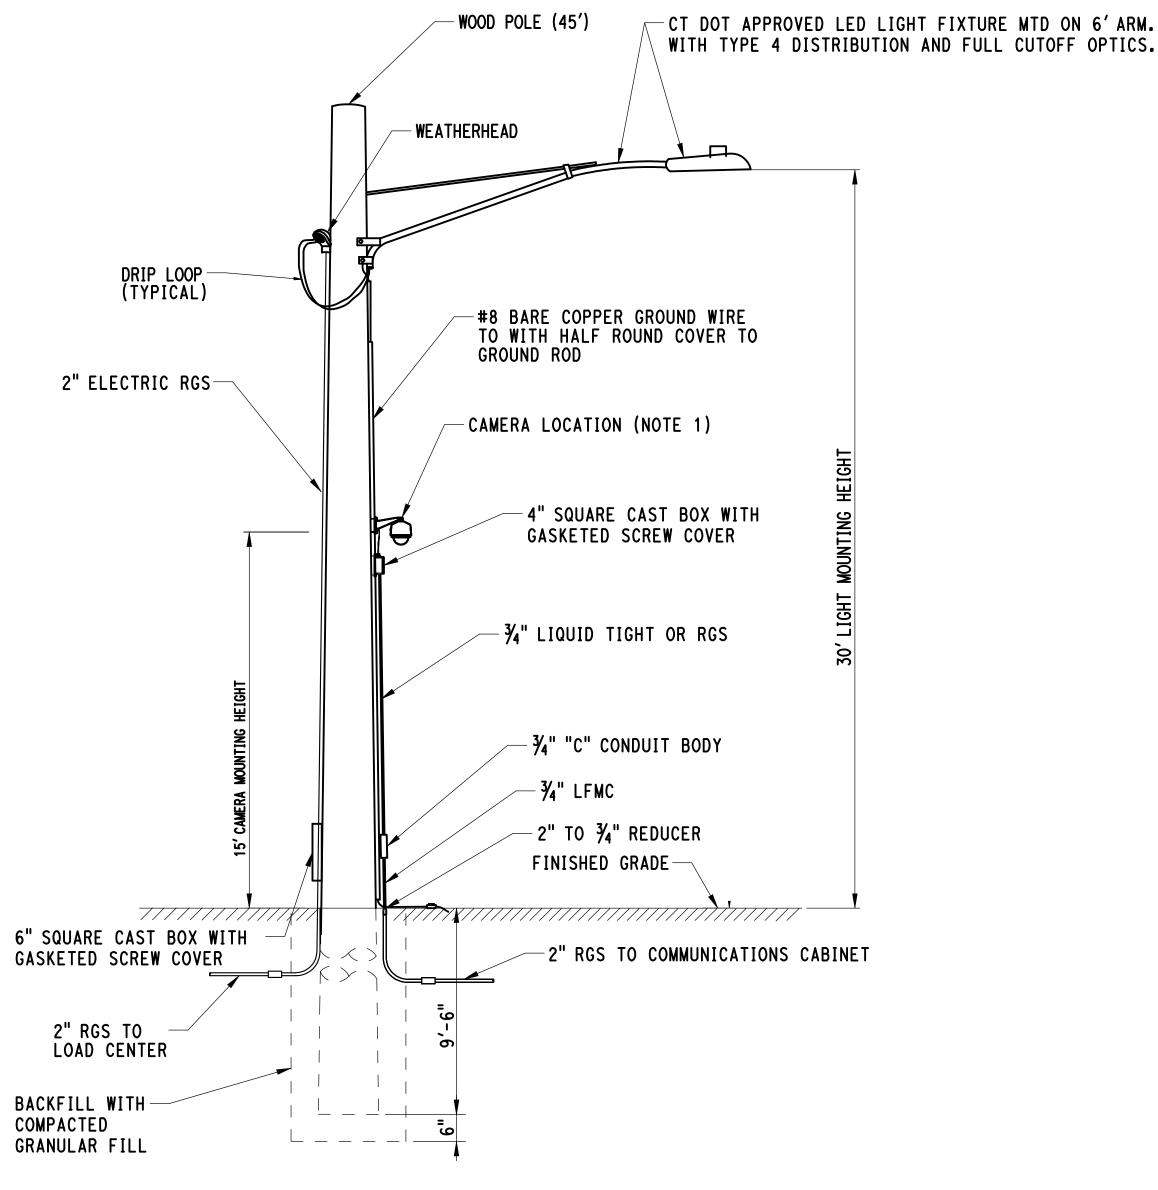

NOTES:

- 1. REFER TO DWGS SS-701 AND SS-702 FOR POLE LOCATIONS.
- 2. CAMERA IS MOUNTED ON WOOD POLE WITH CAMERA AT 15'-0" ABOVE FINAL GRADE.
- 3. EACH CAMERA HAS CAT6 DATA CABLE ROUTED FROM LOCATION AS SHOWN ON DWGS SS-701 AND SS-702.
- 4. REFER TO CIVIL AND UTILITY DWGS FOR ADDITIONAL INFORMATION.

TYPICAL CAMERA/LIGHT POLE

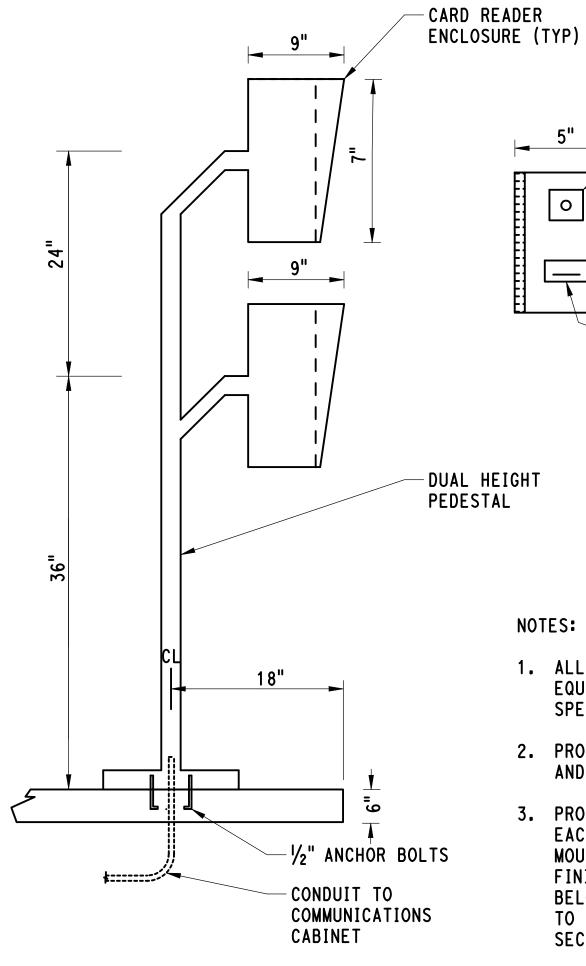

- INTERCOM -CARD READER -DUAL HEIGHT NOTES: 1. ALL CARD READER LOCATIONS SHALL ALSO BE EQUIPPED WITH INTERCOMS. REFER TO 2. PROVIDE DUAL HEIGHT CARD READER ENCLOSURES

- SPECIFICATIONS FOR ADDITIONAL INFORMATION.
- AND PEDESTALS AT ALL GATE LOCATIONS.
- 3. PROVIDE SINGLE CARD READER ENCLOSURE ON EACH SIDE OF THE 4' CHAIN LINK EGRESS GATE.
 MOUNT ENCLOSURES BACK TO BACK AT 42" ABOVE FINISH GRADE ON STRIKE SIDE OF GATE. EXTEND BELOW GRADE RGS COMMUNICATIONS CONDUIT UP TO BOTTOM OF CARD READER ENCLOSURE ON SECURE SIDE OF FENCE.

CARD ACCESS READER PEDESTAL

REVISION DESCRIPTION SHEET NO. Plotted Date: 11/10/2014 REV. DATE

SG/MA JWL NOT TO SCALE

STATE OF CONNECTICUT **DEPARTMENT OF TRANSPORTATION** Filename: 16_SSCD_3010088_SS-703.dgn



NEW HAVEN RAIL YARD YARD POWER UPGRADE

NEW HAVEN 301-0144 SS-703 DRAWING TITLE: SITE SECURITY SHEET NO. **DETAILS** 06.04

FACILITIES IMPROVEMENTS